

		FOC	D SERVICE EQUIPM	ENT LIST
ITEM		VTITY		
NO	QTY	LOT	DESCRIPTION	MANUFACTURER
1	2		HEATED CABINET, PASS-THRU	Continental Refrigerator
2	1		FIRE SUPPRESSION SYSTEM	ANSUL
3	1		TYPE 1 EXHAUST HOOD	AVTEC
4	1		RANGE	GARLAND
5	2		STEAMER, CONNECTIONLESS	ACS
6	1		EQUIPMENT STAND DOUBLE	ACS
7	1		TILTING SKILLET	CLEVELAND
8	2		COUNTERTOP CONVEYOR OVEN	LINCOLN
8.1	1		MOBILE EQUIPMENT STAND (36"X36")	FABRICATOR
9	2		STACKED CONVECTION OVENS	VULCAN
10	1		CONDENSATE HOOD	AVTEC
11	4		END CAP	FABRICATOR
12	1		STAINLESS STEEL WALL FLASHING	FABRICATOR
13	1		SERVICE COUNTER	EAGLE
14	2		MERCHANDISER WARMERS	HATCO
15	2		HEATED STONE SHELVES DROP-IN	HATCO
16	2		HEATED WELLS, MANIFOLDED	HATCO
17	2		BREATH GUARDS	BSI
18	1		SERVICE COUNTER	EAGLE
19	1		DROP-IN REFRIGERATED CASE SELF-SERVE	STRUCTURAL CONCEPTS
20	0		SPARE NUMBER	
21	1		SERVICE COUNTER	EAGLE

FOODSERVICE PLAN

1/4" = 1'-0"



No.	Description	Date

FOODSE	ERVICE LAY	OUT
Project number	077	
Date	3/10/16	FS1.01
Drawn by	RS	
Checked by	RS	Scale 1/4" = 1'-0"

				FOOD SI	ERVICE EQ	UIPMEI	NT &	EXHAUS	T SCH	IEDUL	E.					
				EQUIPMENT								V	'ENTII	LATIC	NC	
ITE M						-URNISHED	NSTALLED	C DUCT W	C. DUCT D	CFM	S.P	MAKE-UP W	MAKE-UP. D	MAKE-UP CFM	MAKE-UP S.P.	
NO	QTY	LOT	DESCRIPTION	MANUFACTURER	MODEL			EX.	X	EX.	EX	Ž	Ž	Ž	Ž	VENTILATION REMARKS
1	2		HEATED CABINET, PASS-THRU	Continental Refrigerator	DL1WE-SS-PT	KEC	KEC									
2	1		FIRE SUPPRESSION SYSTEM		R-102	KEC	KEC									
3	1		TYPE 1 EXHAUST HOOD	AVTEC	ECO-ARCH	KEC	KEC	12"	8"	2100	1.00	0"	0"	0	0.00	(2) DUCT COLLARS
4	1		RANGE	GARLAND	GFE24-4L	KEC	KEC									
5	2		STEAMER, CONNECTIONLESS	ACS	(1) New (1) EXISTING	OFCI/K EC	KEC									
6	1		EQUIPMENT STAND DOUBLE	ACS	DE STAND CA	KEC	KEC									
7	1		TILTING SKILLET	CLEVELAND	SGL-30-T1	OFCI	KEC									
8	2		COUNTERTOP CONVEYOR OVEN	LINCOLN	1116-000-U	OFCI	KEC									
8.1	1		MOBILE EQUIPMENT STAND (36"X36")	FABRICATOR	EXISTING	OFCI	OFCI									
9	2		STACKED CONVECTION OVENS	VULCAN	SG44C	OFCI	KEC									
10	1		CONDENSATE HOOD	AVTEC	CUSTOM ECO	KEC	KEC	10"	15"	1875	0.25					MAKE-UP EXISTING BY OWNER
11	4		END CAP	FABRICATOR	CUSTOM	KEC	KEC									
12	1		STAINLESS STEEL WALL FLASHING	FABRICATOR	CUSTOM	KEC	KEC									
13	1		SERVICE COUNTER	EAGLE	CUSTOM	KEC	KEC									
14	2		MERCHANDISER WARMERS	HATCO	GR2SDS-30D	KEC	KEC									
15	2		HEATED STONE SHELVES DROP-IN	HATCO	GRSSB-2418	KEC	KEC									
16	2		HEATED WELLS, MANIFOLDED	HATCO	HWBI-2M	KEC	KEC									
17	2		BREATH GUARDS	BSI	ZG9945	KEC	KEC									
18	1		SERVICE COUNTER	EAGLE	CUSTOM	KEC	KEC									
19	1		DROP-IN REFRIGERATED CASE SELF-SERVE	STRUCTURAL CONCEPTS	DOS4837R	KEC	KEC									
20	0		SPARE NUMBER													
21	1		SERVICE COUNTER	EAGLE	CUSTOM	KEC	KEC									



No.	Description	Date


EQUIPM	IENT SCHE	DULE
roject number	077	
ate	3/10/16	FS1.02
rawn by	RS	1
hecked by	RS	Scale

	FOC	DSER	VICE	EELE	CTRIC	CALS	SCHE	DULE		
	EQUIPMENT							ELEC	TRIC	AL
ITEM NO	DESCRIPTION	VOLTS	PHASE	AMPS	KW	Ŧ	ELECTRICAL AFF	NEMA PLUG	DIRECT CONNECTION	ELECTRICAL REMARKS
1	HEATED CABINET, PASS-THRU	120	1	7.20	1.50		84"			KEC provide cord and plug
2	FIRE SUPPRESSION SYSTEM									
3	TYPE 1 EXHAUST HOOD	120	1	10.00			120"		X	KEC to provide LED Lights
4	RANGE	120	1	1.00						
5	STEAMER, CONNECTIONLESS	208	3	34.00	12.00			L6-30P		ELECTRICIAN VERIFY NEMA PLUG
6	EQUIPMENT STAND DOUBLE									
7	TILTING SKILLET	120	1	10.00			18"	5-15P		ELECTRICIAN VERIFY NEMA PLUG
8	COUNTERTOP CONVEYOR OVEN	120	1				18"	5-15P		ELECTRICIAN VERIFY VOLTAGE AND PLUG
8.1	MOBILE EQUIPMENT STAND (36"X36")									
9	STACKED CONVECTION OVENS	120	1	9.00	0.00	0.5	18"	5-15P		ELECTRICIAN VERIFY NEMA PLUG
10	CONDENSATE HOOD	120	1	10.00					Х	KEC to provide LED lights
11	END CAP									
12	STAINLESS STEEL WALL FLASHING									
13	SERVICE COUNTER									
14	MERCHANDISER WARMERS	208	1	9.81	2.04		18"	14-20P		NOTE: DUAL VOLTAGE120/208V - REDUCED TO 8.5 AMPS
15	HEATED STONE SHELVES DROP-IN	120	1	5.30	0.64		18"			
16	HEATED WELLS, MANIFOLDED	208	1	11.60	2.42					
17	BREATH GUARDS									
18	SERVICE COUNTER									
19	DROP-IN REFRIGERATED CASE SELF-SERVE	120	1	16.00	1.48		18"	5-20P		
20	SPARE NUMBER									
21	SERVICE COUNTER									





No.	Description	Date
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ELECTR	RICAL SCHE	DULE
Project number	077	
Date	3/10/16	FS1.03
Orawn by	RS	
Checked by	Checker	Scale

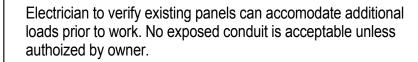

Electrician verify circuits for (2) fans wired to (1) switch



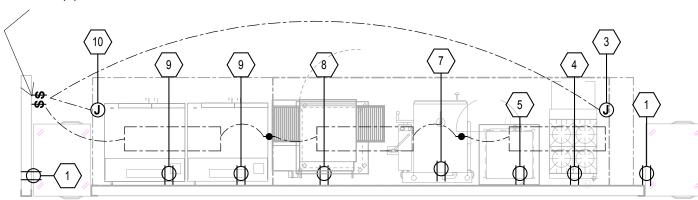

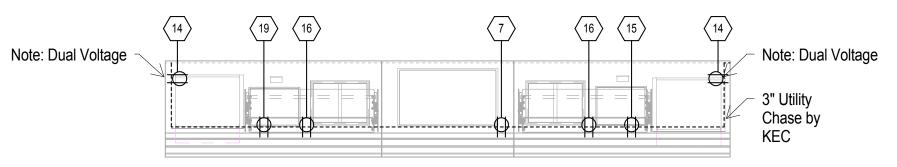ELECTRICAL ROUGH-IN

ELECTRICAL SYMBOLS:

- \Diamond WALL MOUNTED DUPLEX **OUTLET**
- JUNCTION BOX
- **EQUIPMENT CONNECTION**
- FLUORESCENT LIGHT FIXTURE WITH LOW TEMPERATURE BALLAST BY KEC
 - **SWITCH**
 - A HIGH TEMP ALARM PANEL
 - D DATA CONNECTION

1/4" = 1'-0"





No.	Description	Date

ELECTRICAL SYMBOLS LEGEND 1/4" = 1'-0"

 ELECTR	RICAL ROUG	SH-IN
Project number	077	
Date	3/10/16	FS2.01
Drawn by	RS	. 02.0
Checked by	RS	Scale 1/4" = 1'-0"

Plumber to disconnect an reconnect all existing equipment. Re-rout gas and water to accomodate repositioning of equipment.

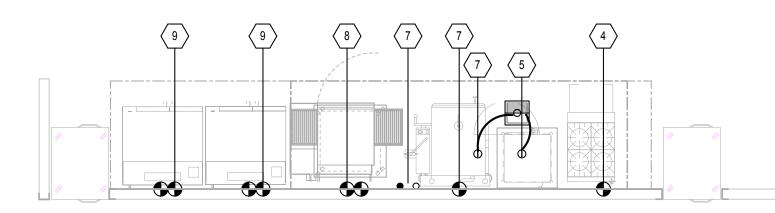

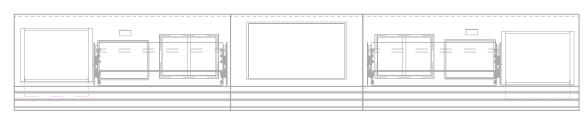








ONTARIO SD ONTARIO HS

No.	Description	Date

PLUMBING SYMBOLS:


- o COLD WATER
- HOT WATER
- • HOT & COLD WATER
- Φ INDIRECT WASTE CONNECTION
- FLOOR DRAIN
- FLOOR DRAIN WITH FUNNEL
- FLOOR SINK
- GAS CONNECTION
- REFRIGERATION CONNECTION
- FLOOR DRAIN WITH 24" SQUARE SLOPED AREA TO DRAIN

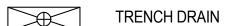

PLUMBING SYMBOLS LEGEND

1/4" = 1'-0"

PLUMBING ROUGH-IN						
Project number	077					
Date	3/10/16	FS2.02				
Drawn by	RS	. 02.02				
Checked by	Checker	Scale 1/4" = 1'-0"				

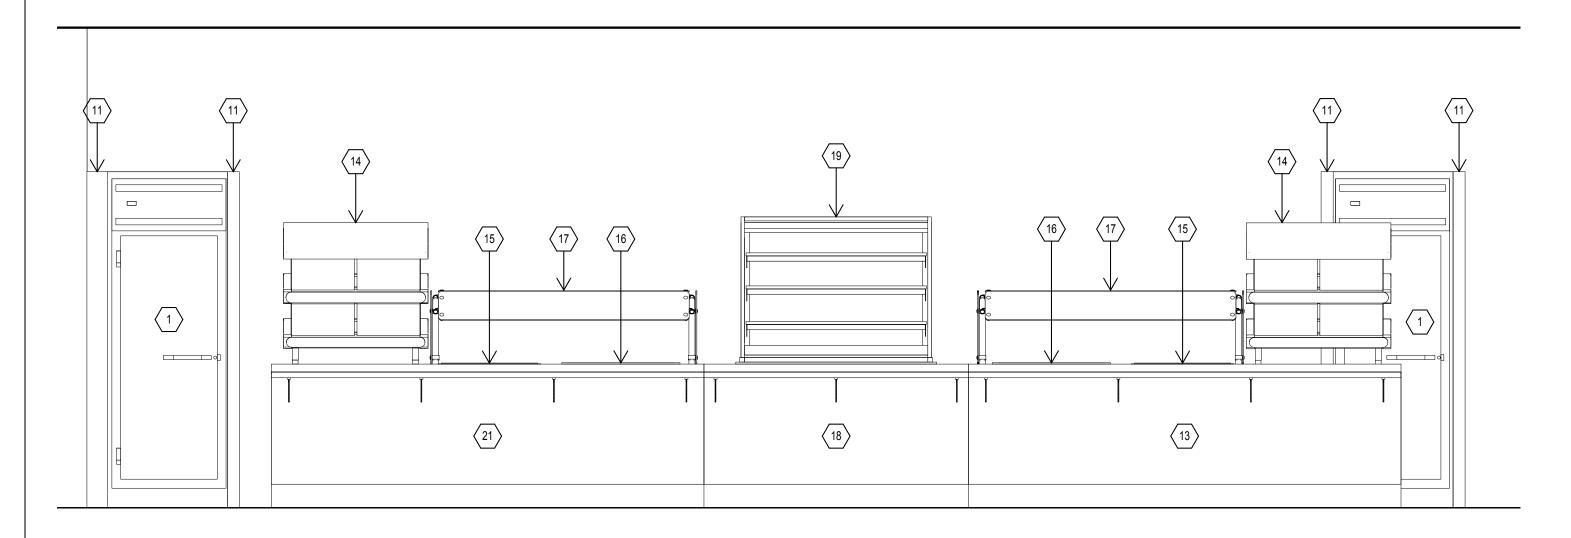







No.	Description	Date

ELEVATIONS						
Project number	077	- 0000				
Date	3/10/16	FS3.01				
Drawn by	RS					
Checked by	RS	Scale 1/2" = 1'-0"				

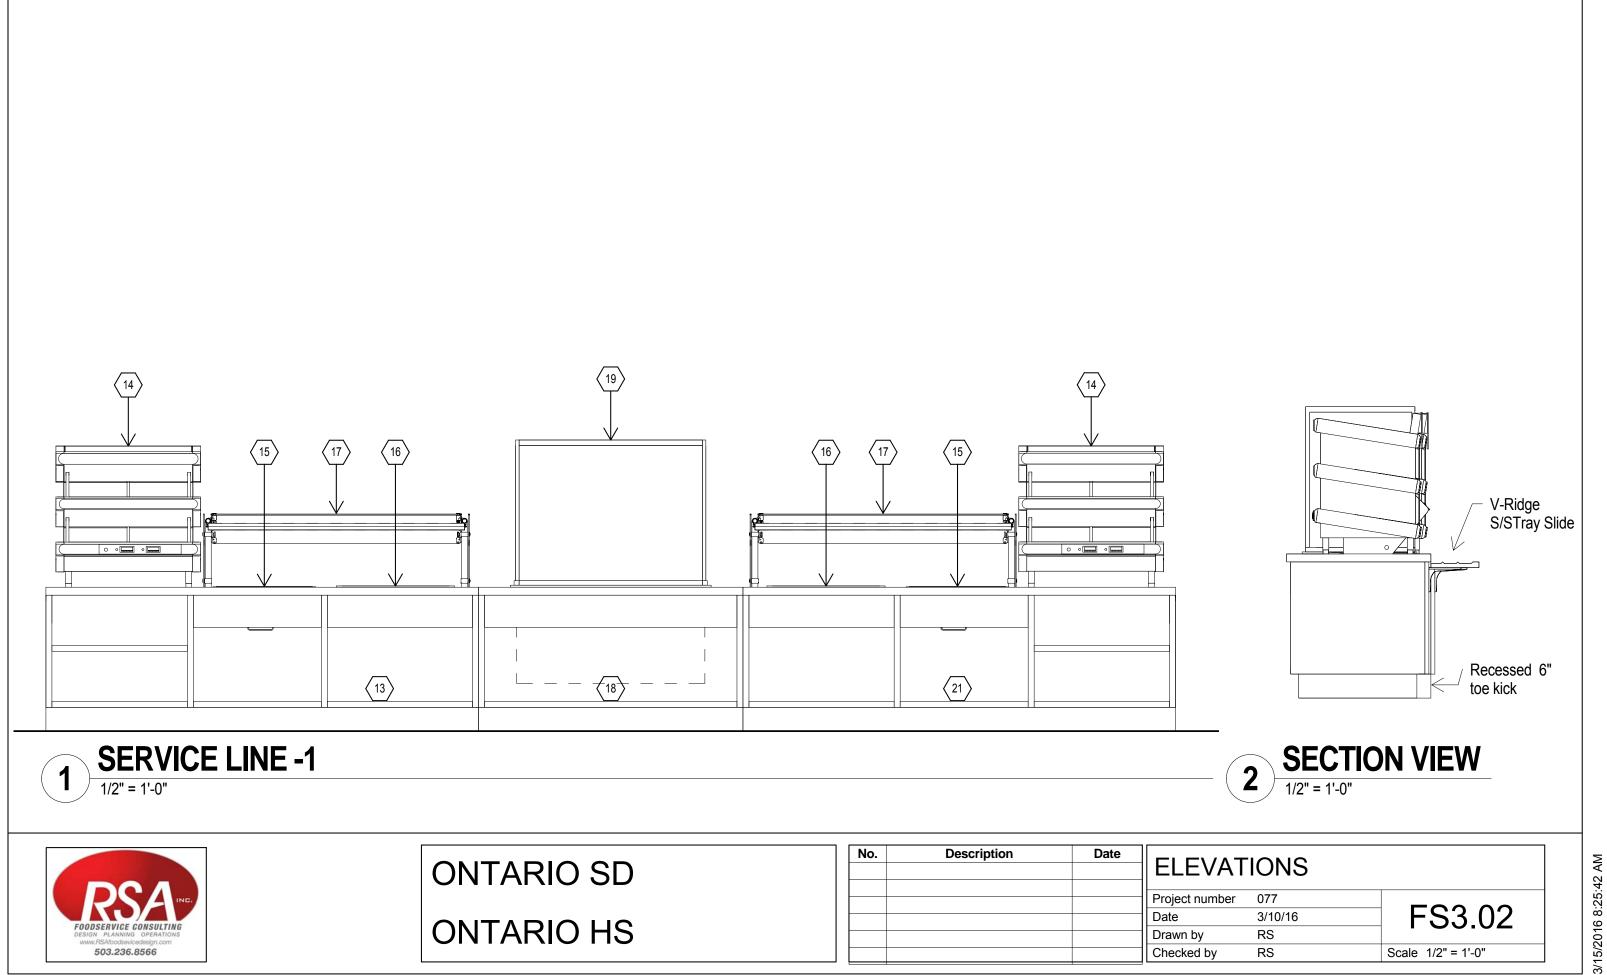


ELEVATIONS ONTARIO SD Project number 077 FS3.02 3/10/16 **ONTARIO HS** Drawn by Scale 1/2" = 1'-0" 503.236.8566 Checked by

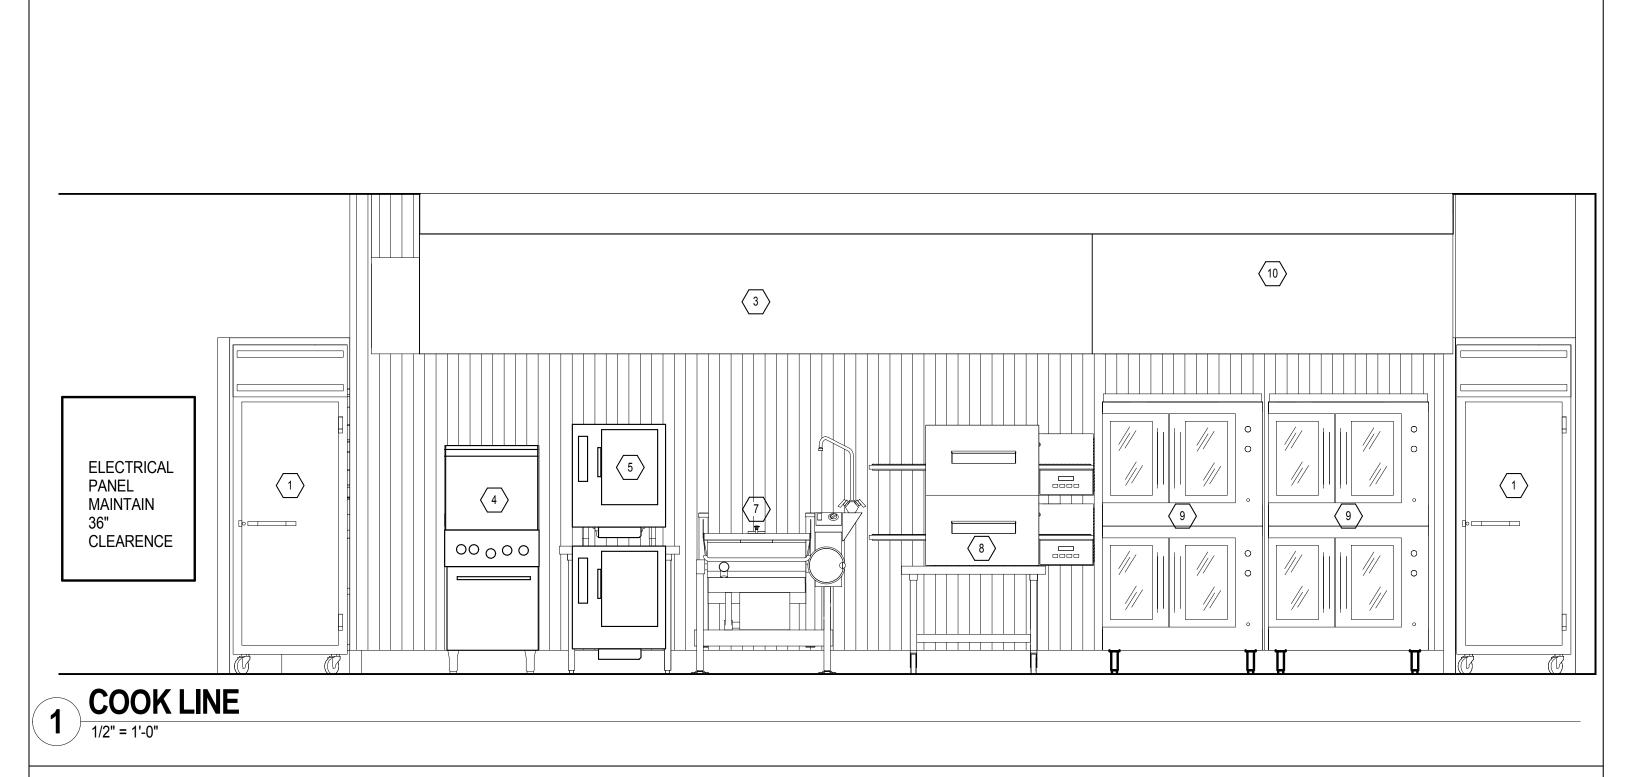



No.	Description	Date

ELEVATIONS						
Project number	077	- 0000				
Date	3/10/16	FS3.03				
Drawn by	RS					
Checked by	RS	Scale 1/2" = 1'-0"				

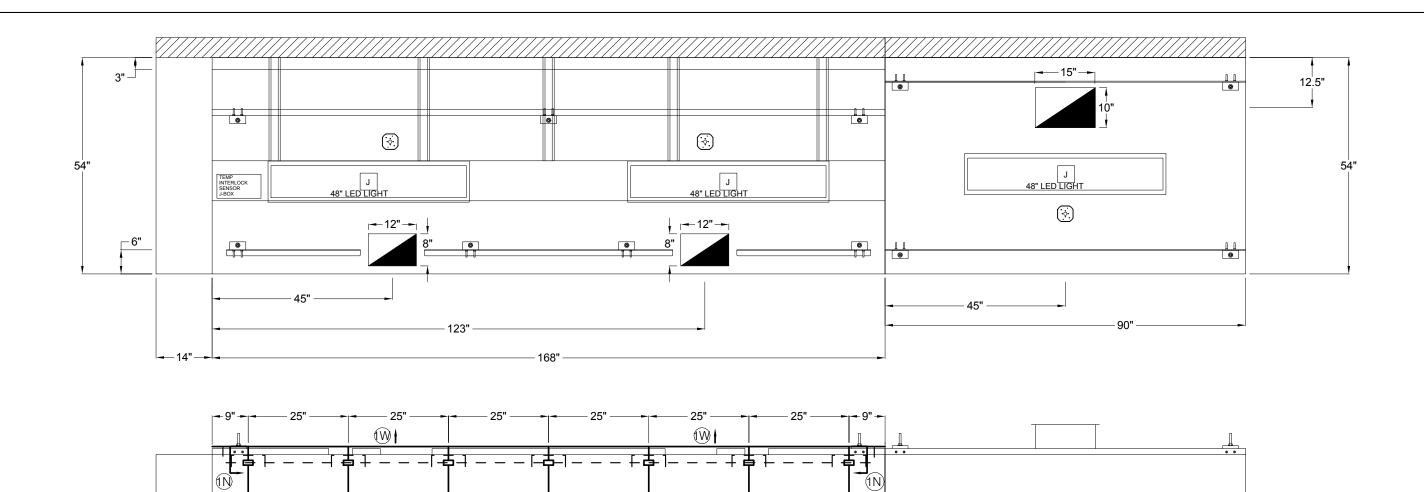

						E)	KHAUST						S	UPPLY						FILT	TERS-C	ARTRIDGES		
HOOD ITEM	APPROX HOOD HANGING WEIGHT	HOOD LENGTH	HOOD WIDTH	TOTAL EXH. CFM	EXH RATE (LIN. FT)	C F-B	OLLARS L-R	CFM	EXH DUCT VELOCITY	S.P W.C. AT COLLAR	SUPPLY CFM	L-R	COLLARS F-B	CFM	SUPPLY DUCT VELOCITY	S.P W.C. AT COLLAR	HEIGHT	WIDTH	QTY	CART	. VOL	CFM PER CART/FILTER	CART/FILTER VELOCITY (FPM)	NET AREA SQ. FE
						8	12	1050	1575	1.0					*		16	20	5			233	(FFW) 533	3.7
_	700	400	۱	0400	450	8	12	1050	1575	1.0							16	16	4					
3	788	168	54	2100	150							•				•								
											1	•				•								
						10	15	1875	1575	.25						•								
40	400	00	- 4	4075	250						*					•								
10	422	90	54	1875	250											•								
											1													

AP

AP

HOODS #3 & 10

1/2" = 1'-0"

AP

AP



ONTARIO SD ONTARIO HS

AP


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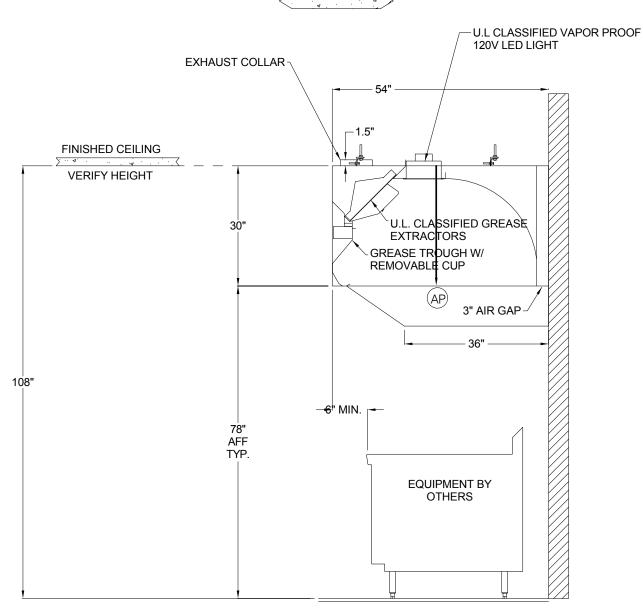
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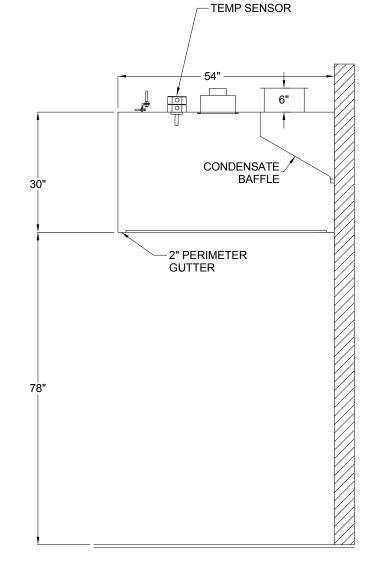
XHAUST HOOD DETAILS						
ect number	077					
е	3/10/16	FS4.01				
wn by	JD					
cked by	Checker	Scale As indicated				

.5" THREADED DRAIN - LOCATED ON RIGHT SIDE



CLEARANCE IS REQUIRED TO CLOSEST OVERHEAD OBSTRUCTION (OR STRUCTURAL CEILING). AVTEC REQUIRES 10" (18" FOR WATER WASH HOODS) FROM THE TOP OF THE VENTILATOR DUCT COLLAR CONNECTION, ACCESS IS THE RESPONSIBILITY OF THE KITCHEN EQUIPMENT CONTRACTOR.



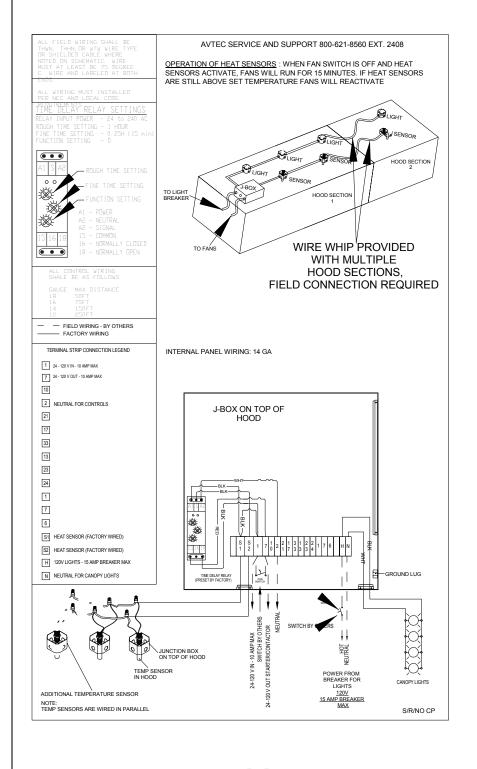

HOOD #10 - ACWO



2 # 3 Hood Section

3 #10 Hood Section



No.	Description	Date	
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EXHAUST HOOD DETAILS						
Project number	077					
Date	3/10/16	FS4.02				
Drawn by	JD	. ••				
Checked by	RS	Scale As indicated				

INSTALLATION REQUIREMENTS

- PROVIDE DRAWINGS TO APPROPRIATE TRADES REFERENCING UTILITY SERVICE AND COORDINATE FINAL CONNECTION.
- DELIVER, ASSEMBLE AND INSTALL AVTEC SYSTEMS PER
- FURNISH WIRING (AND PLUMBING) DIAGRAMS TO END USER.
- THE K.E.C. MUST INFORM AVTEC OF ANY CHANGES IN EQUIPMENT OR BUILDING STRUCTURE. FIELD MODIFICATIONS DUE TO INSUFFICIENT INFORMATION ARE THE RESPONSIBILITY OF THE K.E.C.

RETURN DRAWING (S) TO UNIFIED BRANDS VIA


CS@UNIFIEDBRANDS.NET

888-200-4975

MAILED HARD COPIES

UNIFIED BRANDS 525 S COLDWATER RD WEIDMAN, MI 48893

BUILDING MUST HAVE PASSAGEWAY LARGE ENOUGH TO PASS (FOR CRATED UNITS ADD 6" TO EACH DIM.)

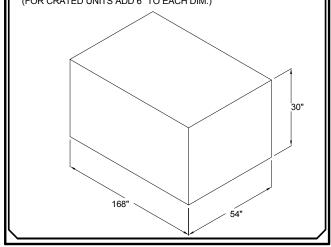

NOTES TO KEC

THE INFORMATION PROVIDED ON THIS DRAWING HAS BEEN GENERATED BASED ON THE LATEST INFORMATION SENT TO AVTEC. AVTEC MUST BE NOTIFIED IN WRITING ANY DEVIATION FROM THE INFORMATION SHOWN ON THIS DRAWING AND OR NOTES BELOW. ANY MODIFICATION TO AVTEC PRODUCT DURING OR AFTER FABRICATION WILL BE THE RESPONSIBILITY OF THE KEC. ALSO NOTE THAT ANY DEVIATION DURING FABRICATION MAY RESULT IN A CHANGE TO THE SCHEDULED SHIP DATE

- KEC MUST ENSURE HOOD DIMENSIONS AS SHOWN WILL PROVIDE PROPER CAPTURE FOR ALL COOKING EQUIPMENT.
- (6"MIN OVERHANG REQUIRED ON EACH OPEN SIDE) (12"MIN OVERHANG RECOMMENDED FOR BROILERS)
- EQUIPMENT SECTIONS AS DIMENSIONED WILL ACCESS MOST POINTS OF INSTALLATION. IF ADDITIONAL FIELD JOINTS ARE REQUIRED THE KEC MUST NOTIFY AVTEC PRIOR TO FABRICATION.
- ALL DIMENSIONS SHOWN ARE EQUIPMENT DIMENSIONS. OVERALL DIMENSIONS ARE +/- 1/4" CONSTRUCT WALLS TO SUIT EQUIPMENT DIMENSIONS.
- HOODS ARE CONSTRUCTED IN ACCORDANCE WITH AVTEC'S UL LISTING AND NFPA 96 INCLUDING EXCEPTIONS.
- IT IS THE RESPONSIBILITY OF THE KITCHEN EQUIPMENT CONTRACTOR(K.E.C.) TO SUPPLY THE BULBS FOR USE IN THE WORK LIGHT

GENERAL NOTES

IF YOU ARE INSTALLING A VENTILATION EXHAUST SYSTEM INTO AN AREA WHICH HAS CERTAIN STANDARDS OR CODES OTHER THAN THOSE NORMALLY ACCEPTED IN THE FOOD SERVICE INDUSTRY (NSF,UL,ETC) AVTEC MUST BE ADVISED OF THESE SPECIFICATIONS IN DETAIL BEFORE FABRICATION OF THE EQUIPMENT BEGINS. FAILURE TO ADVISE AVTEC OF SPECIFIC REQUIREMENTS COULD RESULT IN THE JOB BEING DELAYED, ADDITIONAL COSTS, OR вотн.

ALL AVTEC HOODS MEET ONE OR MORE OF THE FOLLOWING

U.L. 710, U.L. 710C, BOCA, NSF, ICBO





SUPPLY DUCT



EXHAUST DUCT



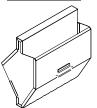

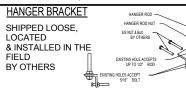

HOLES DRILLED THROUGH HOOD ANGLE (NOT SHOWN) ARE INSTALLED AFTER BRACKET ATTACHMENT POINTS HAVE BEEN DETERMINED. EQUIPMENT MUST BE SUPPORTED BY ALL HANGING BRACKETS PROVIDED. BRACKETS SHIPPED LOOSE FROM FACTORY.

REVISIONS

	REV.	DATE	DESCRIPTION	BY
	Α	2/9/16	REVISE 135584A TO OPTION 1	JDB
	*	*	•	*
	*	*	•	*
	*	*	•	*
	*	*	•	*
	*	*	•	*
	*	*	•	*
•	STATUS:			

PRELIMINARY DRAWING

JD	7/24/15	*	DATE *	
SEE S	HEET DETAIL	ORDER NUMBER		
13558		1 OF	1	

ONTARIO HIGH SCHOOL-OPTION 1

RSA, INC.

RS



Hood Notes




ONTARIO SD ONTARIO HS

	Date	Description	No.
EXHA			
Project numb			
Date			
Drawn by			
Checked by			

XHAUST HOOD DETAILS			
ject number	077	TO 4 00	
е	3/10/16	FS4.03	
wn by	JD	. 0 1100	

Scale 3/4" = 1'-0"

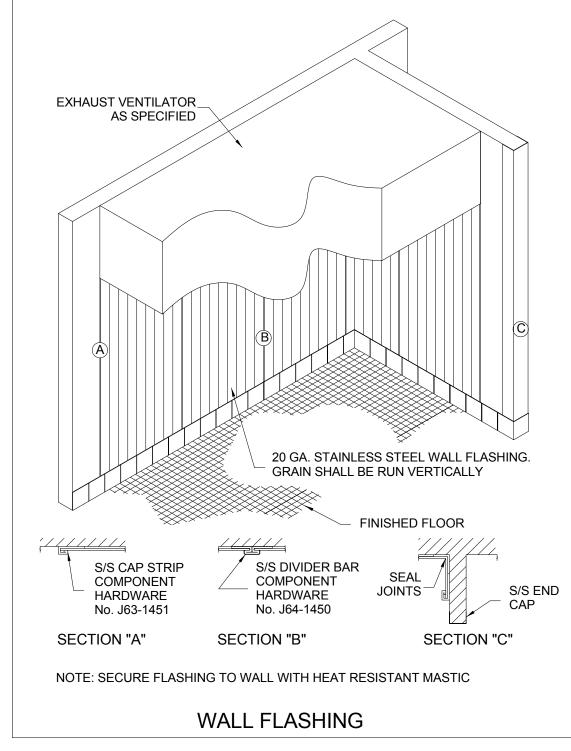




S/S WALL FLASHING

3/8" = 1'-0"



ONTARIO SD ONTARIO HS

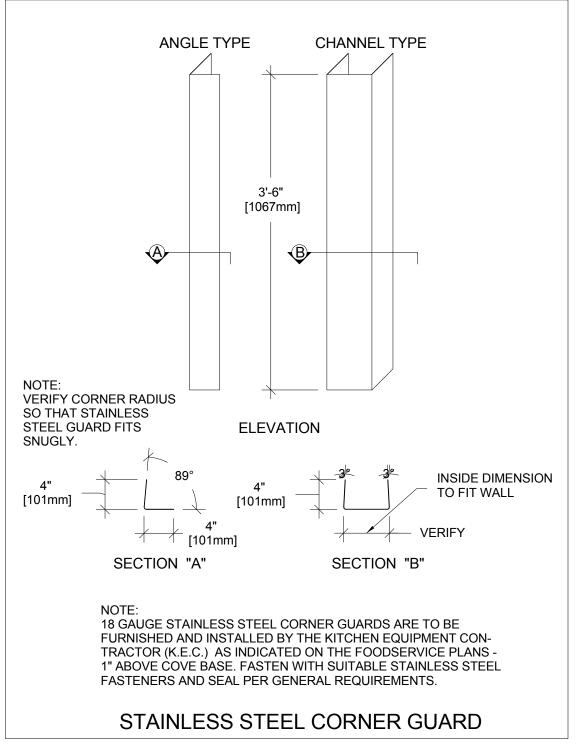


CORNER GUARDS

3/8" = 1'-0"

No.	Description	Date	STA
			Project n
			Date
			Drawn by
			Checked


STAINLESS STEEL TYPICALS

Project number	077	
Date	3/10/16	FS4 04
Drawn by	RS	
Checked by	RS	Scale 3/8" = 1'-0"

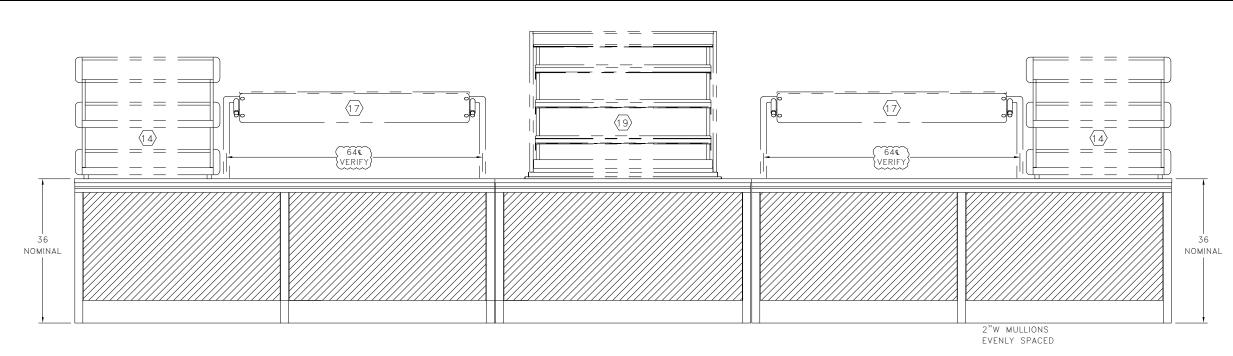

SERVICE LINE FE VIEW

1/2" = 1'-0"

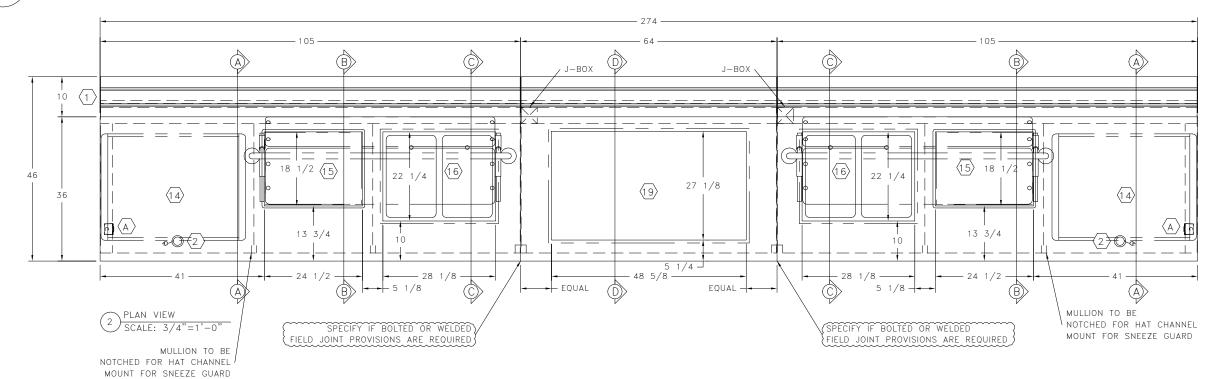

SERVICE LINE DETAILS

1/2" = 1'-0"




ONTARIO SD ONTARIO HS


No.	Description	Date

EAGLE SERVICE LINE DETAILS

Project number	077	
Date	3/10/16	FS4.05
Drawn by	Author	
Checked by	Checker	Scale 1/2" = 1'-0"

3/15/2016 8:25:45 AM

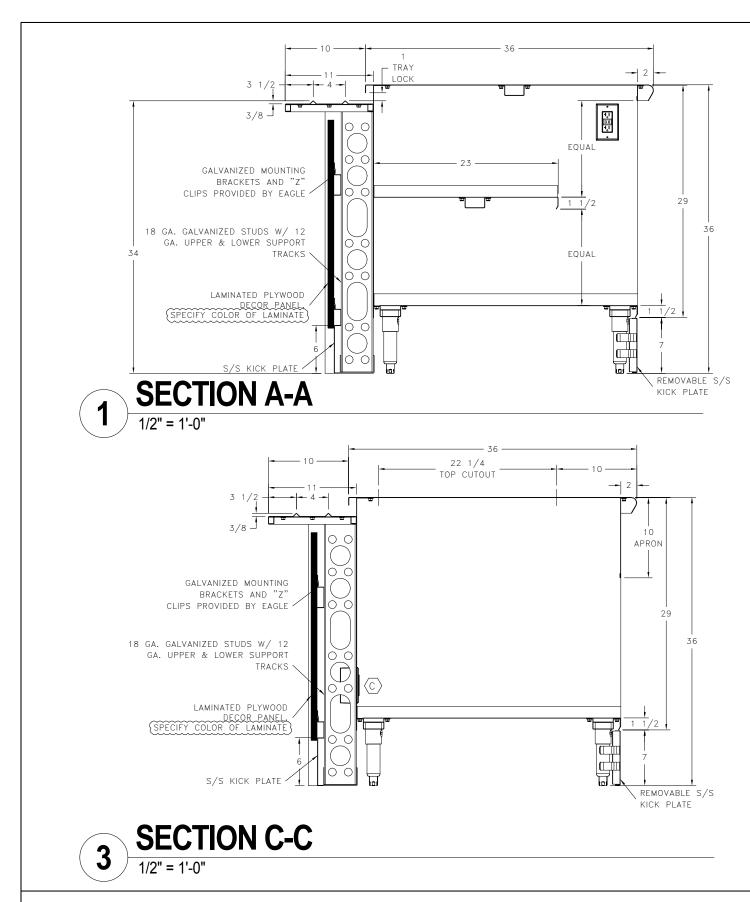

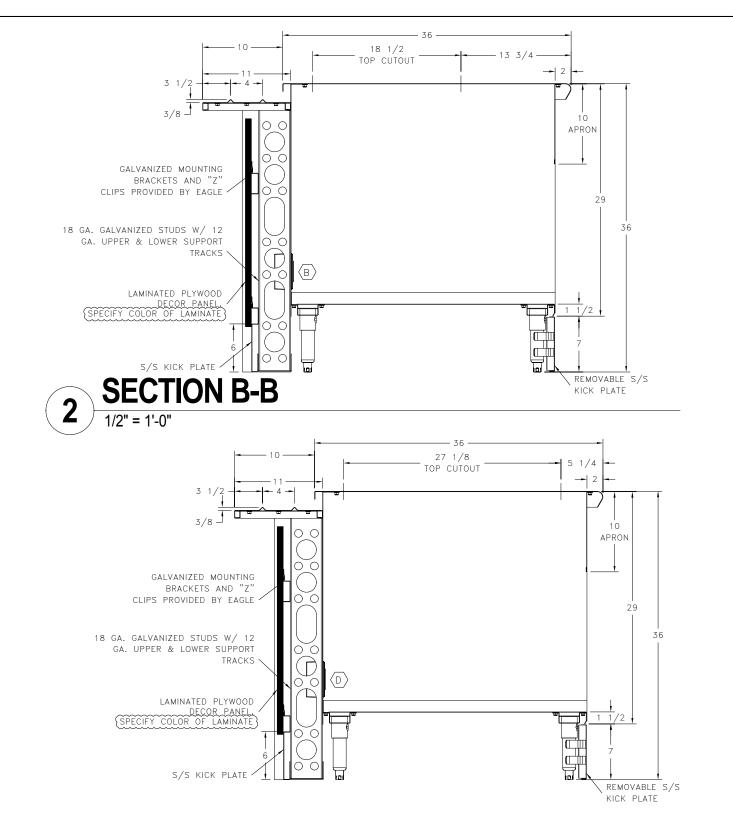

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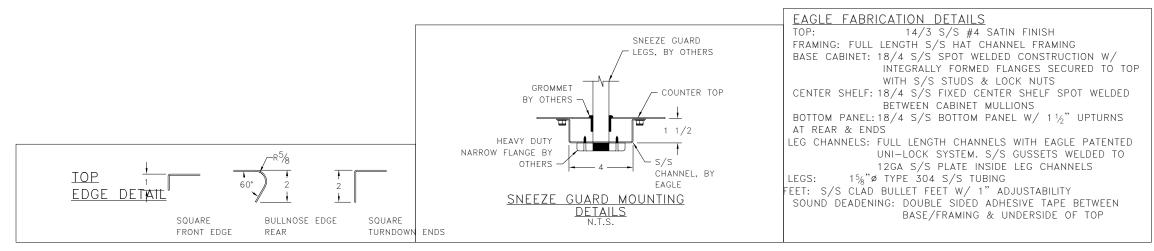
SECTION D-D

1/2" = 1'-0"




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EAGLE SERVICE LINE DETAILS			
Project number	077		
Date	3/10/16	FS4.06	
Drawn by	Author		
Checked by	Checker	Scale 1/2" = 1'-0"	



EDGES-POST MOUNTING

1/2" = 1'-0"

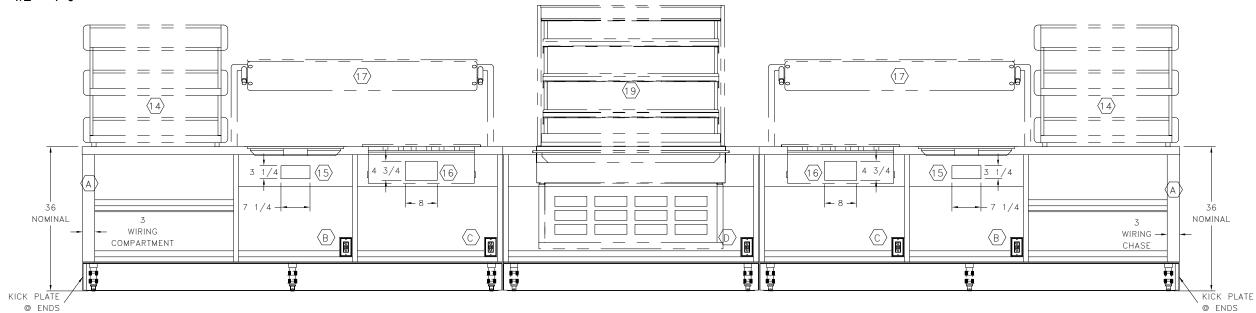

ELE	<u>ELECTRICAL SCHEDULE</u>					
TAG	QTY	DESCRIPTION	ELECTRICAL INFO	SUPPLIED	WIRED	DETAILS/REMARKS
$\langle A \rangle$	2	NEMA 14-20R	RATED 9.81A @ 120/208V (VERIFY)	EAGLE	EAGLE	NEMA 5-20R GFCI CONVENIENCE RECEPTACLE
(70 VENILLY LAGEE LAGE		MOUNTED IN BASE, PRE-WIRED TO J-BOX
$\langle B \rangle$	2	NEMA 5-15R	RATED 5.3A @ 120V (VERIFY)	EAGLE	EAGLE	NEMA 5-20R GFCI CONVENIENCE RECEPTACLE
(P)		TIEMA S TOR	MATER SIGN & TEST (VEILLE)	LAGEL	LAULE	MOUNTED IN BASE, PRE-WIRED TO J-BOX
	2	NEMA 6-15R	RATED 11.6A @ 208V VERIFY)	EAGLE	EAGLE	NEMA 5-20R GFCI CONVENIENCE RECEPTACLE
	-	INEMIA O TSIC	MATER TITOR & 2007 (VENITY)	LAULL	LAULL	MOUNTED IN BASE, PRE-WIRED TO J-BOX
	1	NEMA 5-20R	RATED 15.8A @ 120V VERIFY)	EAGLE	EAGLE	NEMA 5-20R GFCI CONVENIENCE RECEPTACLE
U	'	INEWA 3 ZON	MATER 13.0A & 120V (VENITY)	LAULL	LAULL	MOUNTED IN BASE, PRE-WIRED TO J-BOX

ELECTRICAL- SERVICE LINE

1/2" = 1'-0"



ONTARIO SD ONTARIO HS

No.	Description	Date	
			EAGL
			Project numb
			Date
			Drawn by
			Checked by

EAGLE SERVICE LINE DETAILS		
Project number	077	
Date	3/10/16	FS4.07
Drawn by	Author	

Author

Checker Scale 1/2" = 1'-0"